

Planta de producción de e-Metanol a partir de hidrógeno verde

## Anexo IV - Diagrama de flujo producción H<sub>2</sub>.




Socio estratégico: SEG Ingeniería.



NOTES:  
1. THIS IS A PRELIMINARY PFD DEVELOPED FOR THE FEL-2 OWNER'S ENGINEER AND INTEGRATOR STUDY OF THE HYDROGEN GENERATION FACILITY AT TAMBOR SITE. THE PFD WILL BE UPDATED IN SUBSEQUENT STAGES OF PROJECT BASED ON DESIGN DEVELOPMENT AND VENDOR/LICENSOR INFORMATION.  
2. THIS REPRESENT A COMBINED FLOW, WILL CONTAIN MULTIPLE VENT STACKS WHICH ARE NOT SHOWN

HOLD:  
1. DRAWING DOES NOT REFLECT NUMBER OF THE VENDOR PACKAGES AND EQUIPMENT ARRANGEMENT. CONFIGURATION TO BE UPDATED ONCE CONFIRMED BY VENDOR DETAILS.

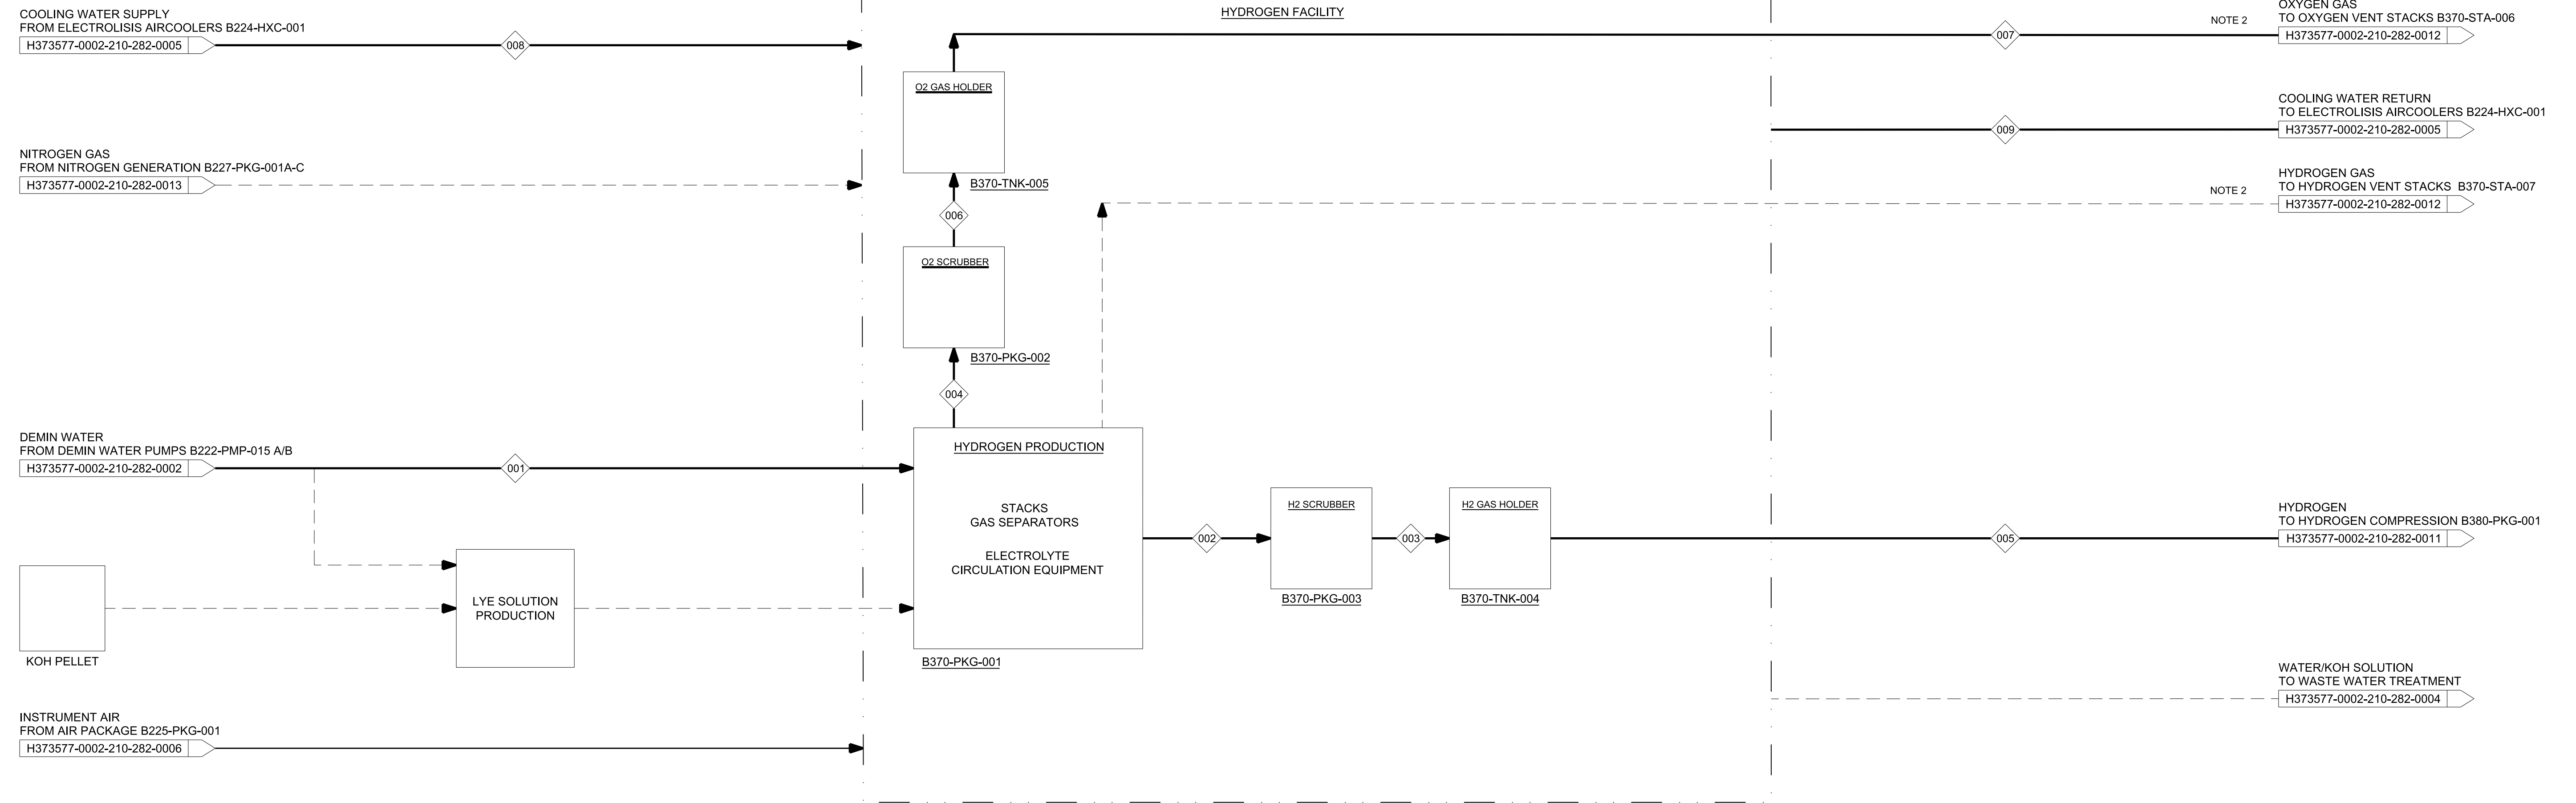

MAJOR FLOW  
MINOR FLOW  
INTERMITTENT FLOW  
VENDOR/LICENSOR PACKAGE

THIS DRAWING WAS PREPARED FOR THE EXCLUSIVE USE OF ENERTRAG URUGUAY S.A ("CLIENT") AND IS ISSUED PURSUANT TO AN AGREEMENT BETWEEN CLIENT AND HATCH LTD. ("HATCH"), UNLESS OTHERWISE AGREED IN WRITING WITH CLIENT OR SPECIFIED ON THIS DRAWING. (A) HATCH DOES NOT ACCEPT AND DISCLAIMS ANY AND ALL LIABILITY OR RESPONSIBILITY ARISING FROM ANY USE OF OR RELIANCE ON THIS DRAWING BY ANY THIRD PARTY OR ANY MODIFICATION OR MISUSE OF THIS DRAWING BY CLIENT, AND (B) THIS DRAWING IS CONFIDENTIAL AND ALL INTELLECTUAL PROPERTY RIGHTS EMBODIED OR REFERENCED IN THIS DRAWING REMAIN THE PROPERTY OF HATCH.



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TAMBOR PROJECT  
FEL2 OWNER'S ENGINEER & INTEGRATOR

METHANOL FACILITY - TAMBOR SITE  
AREA B370 - ELECTROLYZERS  
PROCESS FLOW DIAGRAM

No.	0	APPROVED FOR USE	N.W.	T.W.	10/31/2024
No.	B	CLIENT REVIEW	N.W.	T.W.	10/15/2024
No.	A	INTERNAL REVIEW	N.W.	T.W.	10/01/2024

RefDraw No.	-													
DRAWING No.	DRAWING TITLE		REG. PROFESSIONAL	REVISIONS			DRAWING APPROVAL STATUS: Approved for Use			SCALE NTS OR AS NOTED	DWG. No.	REV		
1	2	3	4	5	6	7	8	9	10	11	12			

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 Release: SA/H373577/01\_Work In Progress/210 - Process - Metanol/PFD/H373577-0002-210-282-0009.dgn